
SITE PLAN 4 UNIT MULTI FAMILY RESIDENCE


180 FORT LEE ROAD, BOROUGH OF LEONIA, BERGEN COUNTY, N.J.

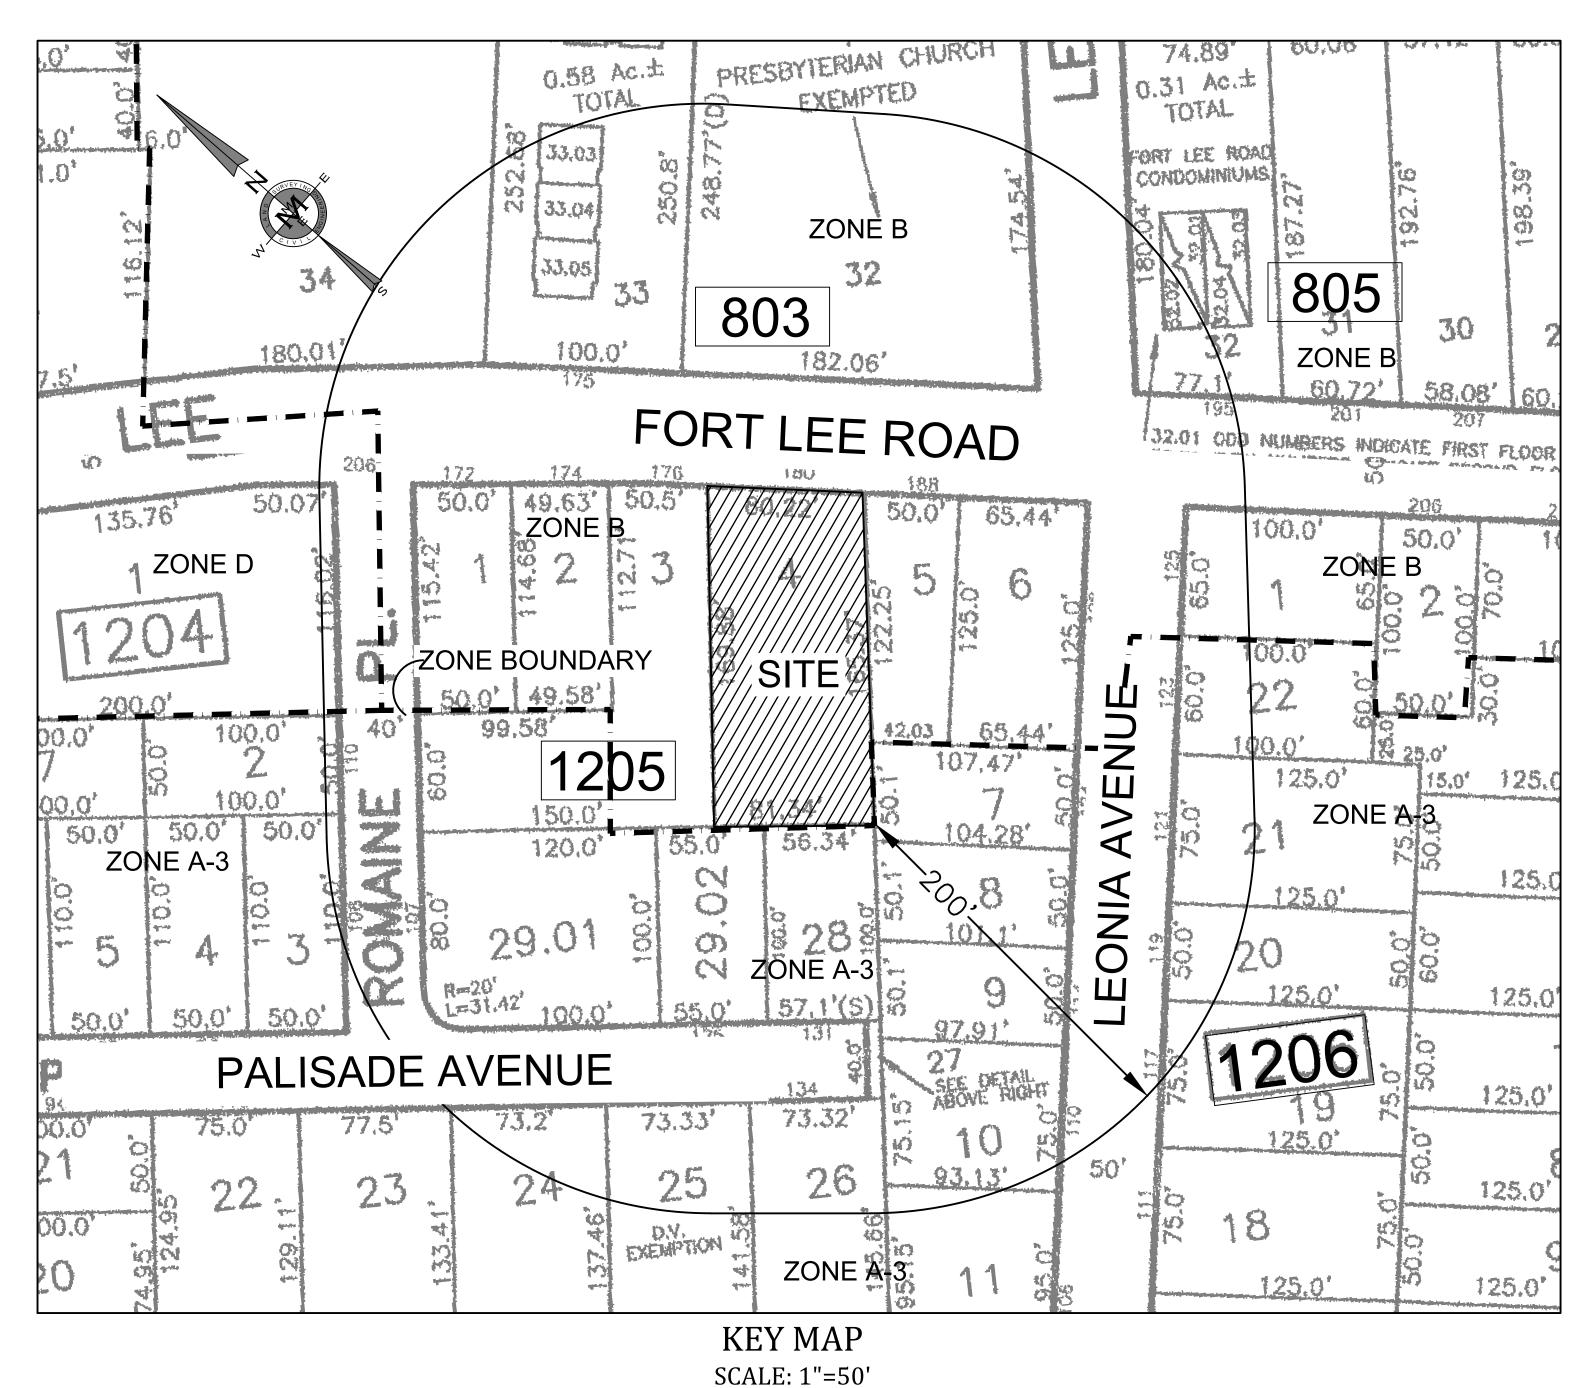

DRAWING SCHEDULE

- EX. CONDITIONS & DEMOLITION PLAN

Applicant: MSN Services LLC 56 Ridge Road Norwood, New Jersey 07648

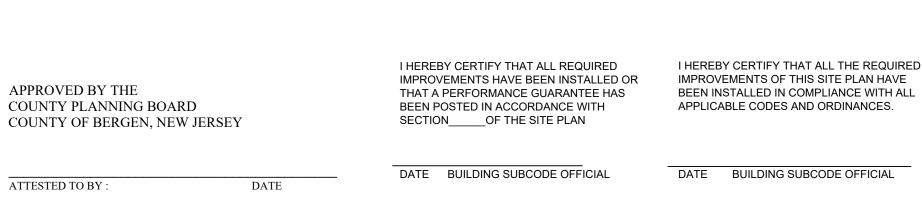

540 BROAD ST, ROOM 2001

HARRINGTON PARK, NJ 07460

NEWARK, NJ 07101

80 PARK PLAZA

MAIL CODE T5E

NEWARK, NJ 07101

40 POTASH ROAD

OAKLAND, NJ 07436

LITTLE FERRY, NJ 07643

ONE BERGEN COUNTY PLAZA-4TH FL.

BOROUGH ENGINEER

BOROUGH ENGINEER

OCCUPANCY PERMIT ISSUED DATE:

200 OLD HOOK ROAD

UTILITIES & PUBLIC AGENCIES:

NEW JERSEY BELL/VERIZON

UNITED WATER RESOURCES C/O CORPORATE SECRETARY

C/O CORPORATE SECRETARY

PUBLIC SERVICE ELECTRIC & GAS CO.

BERGEN COUNTY UTILITIES AUTHORITY


BERGEN COUNTY PLANNING BOARD

CHIEF ENGINEER/ DIRECTOR OF WPC DIV.

RICHARD D. YOUNG III


CABLEVISION


GENERAL MANAGER

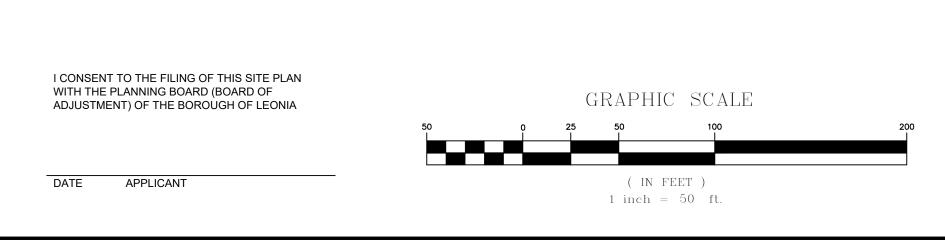

Mark Martins Engineering, LLC 55 WALNUT STREET SUITE 201 NORWOOD, NJ 07648 TEL 201-391-3222 FAX 201-215-2210 MARK S. MARTINS Professional Engineer & Land Surveyor

COVER SHEET LAND **ENGINEERING** SURVEYING 180 FORT LEE ROAD LOT 4 & BLOCK 1205 Situated in the Borough of Leonia Bergen County, NJ DRAWN:SF CHECK'D:MM SCALE: 1" = 50' SHEET 1 OF 7 FILE NO. 14-1883

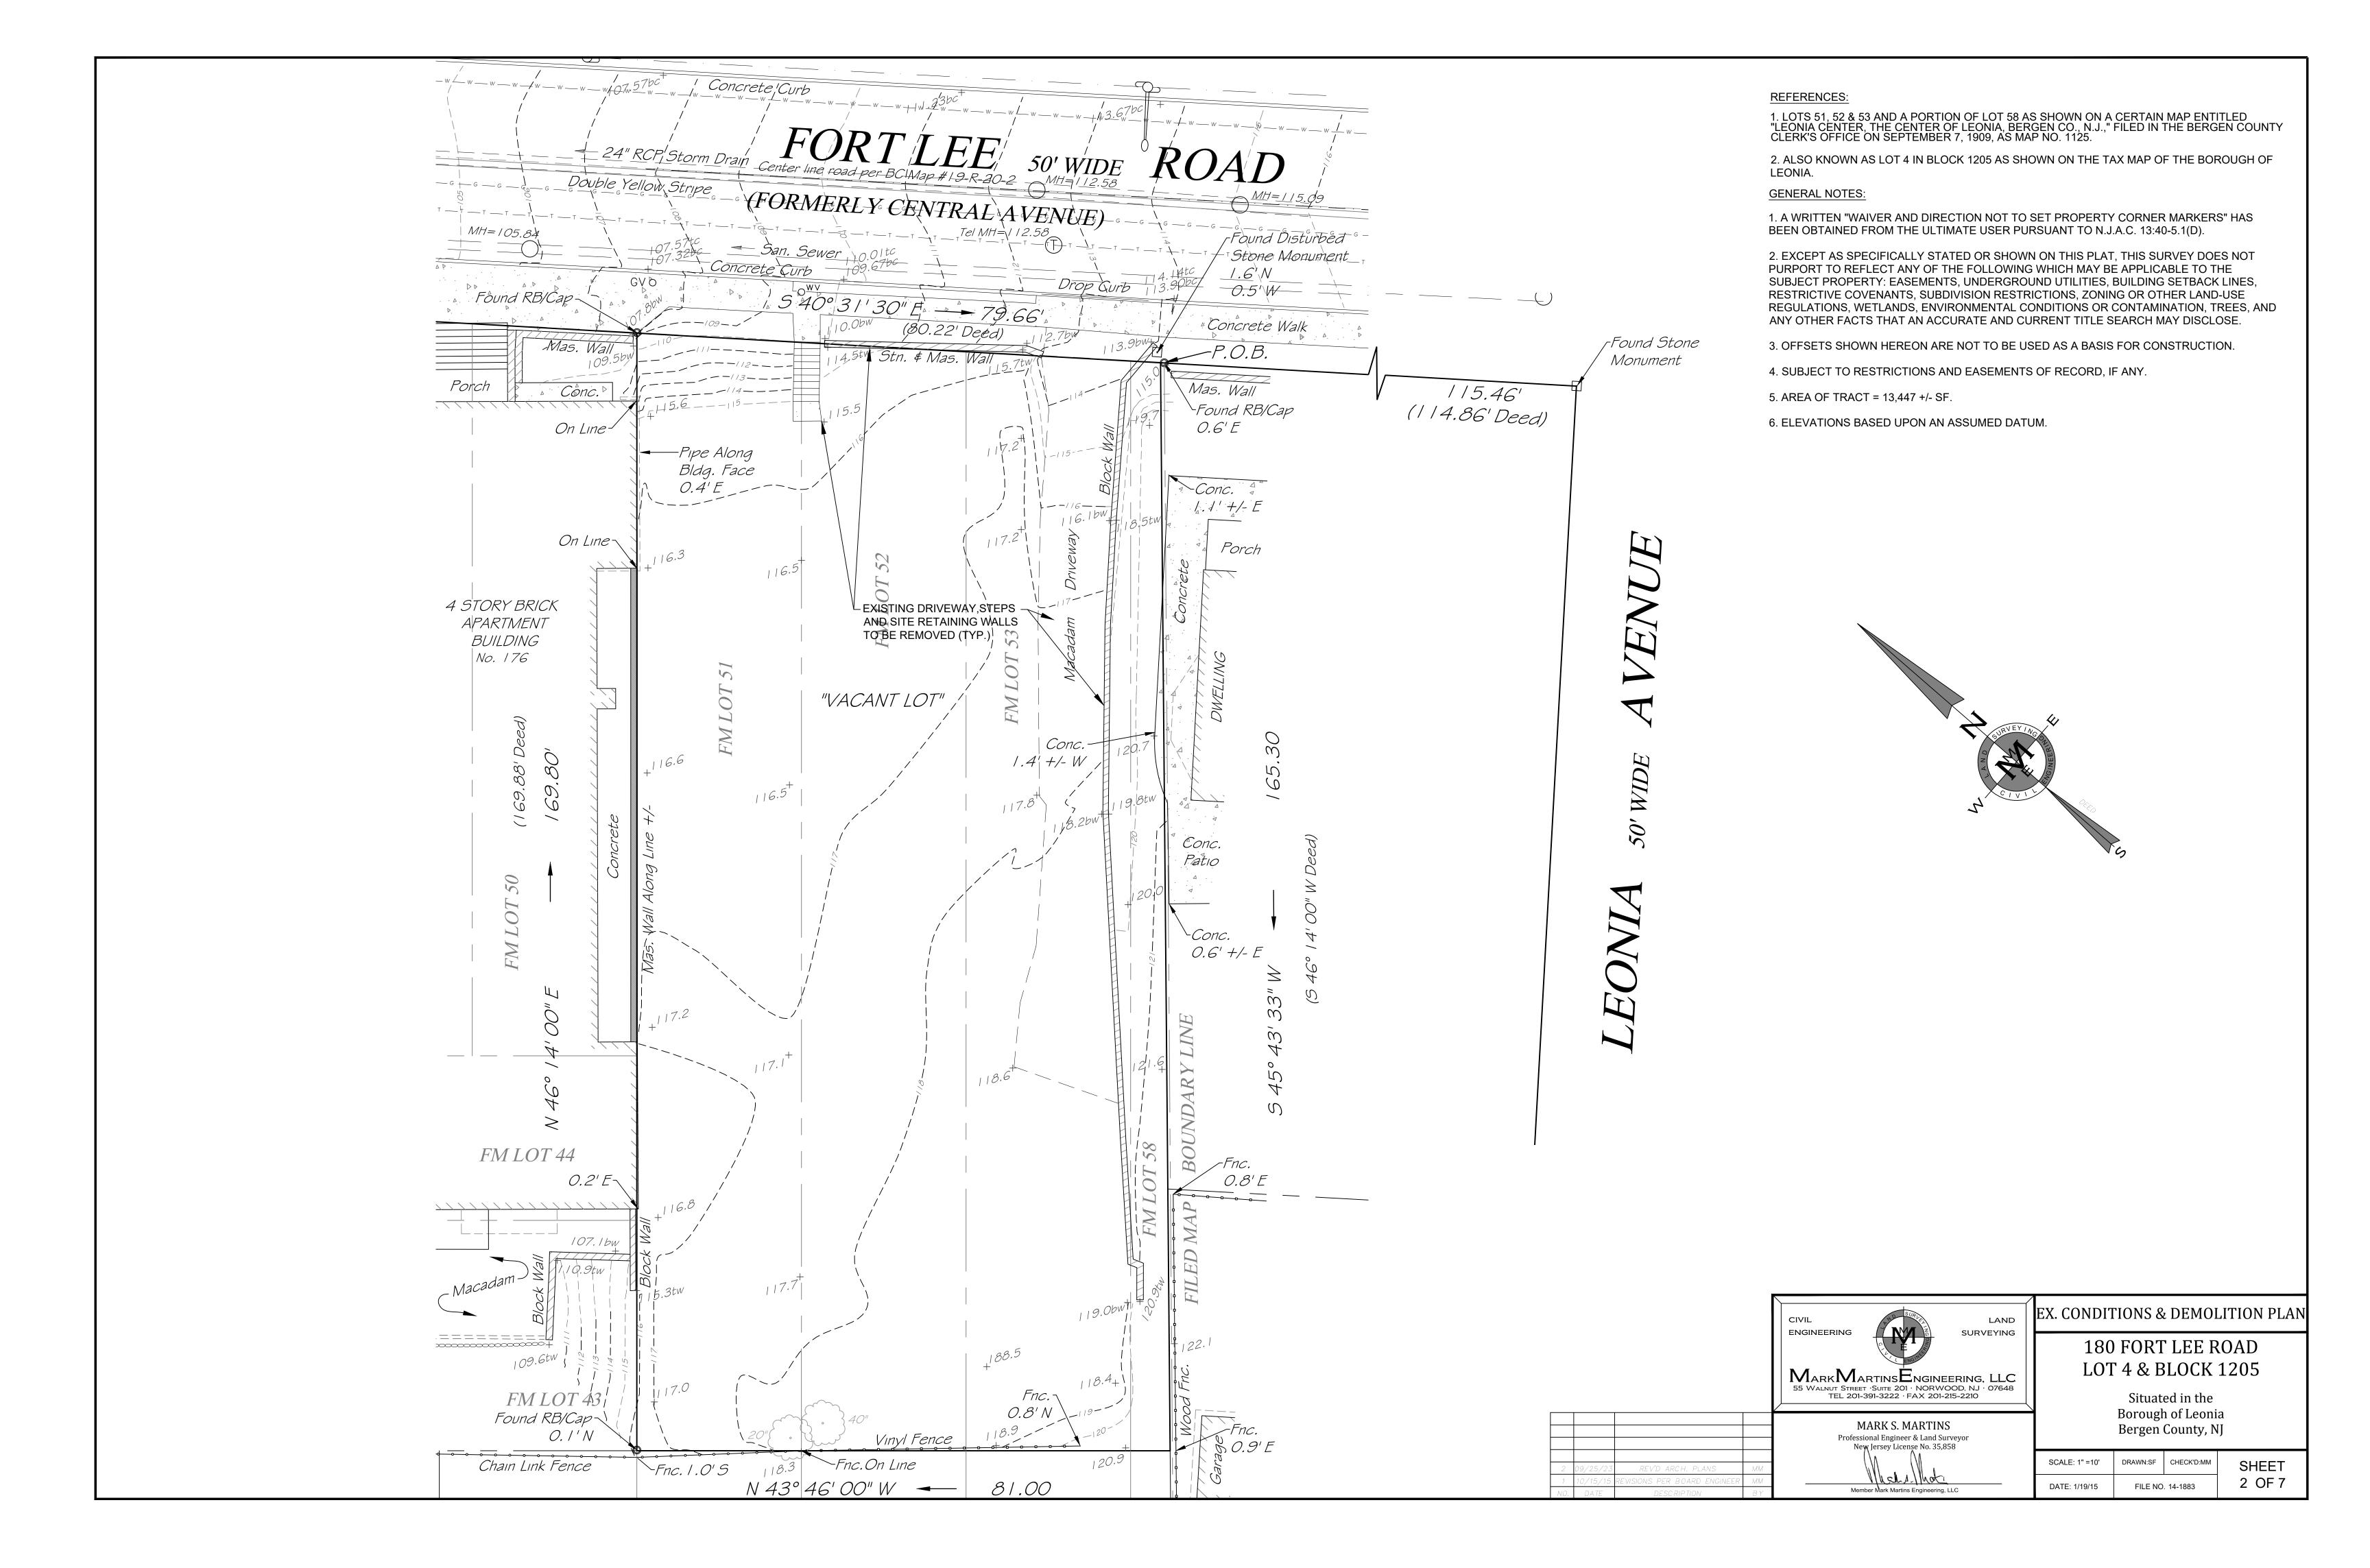

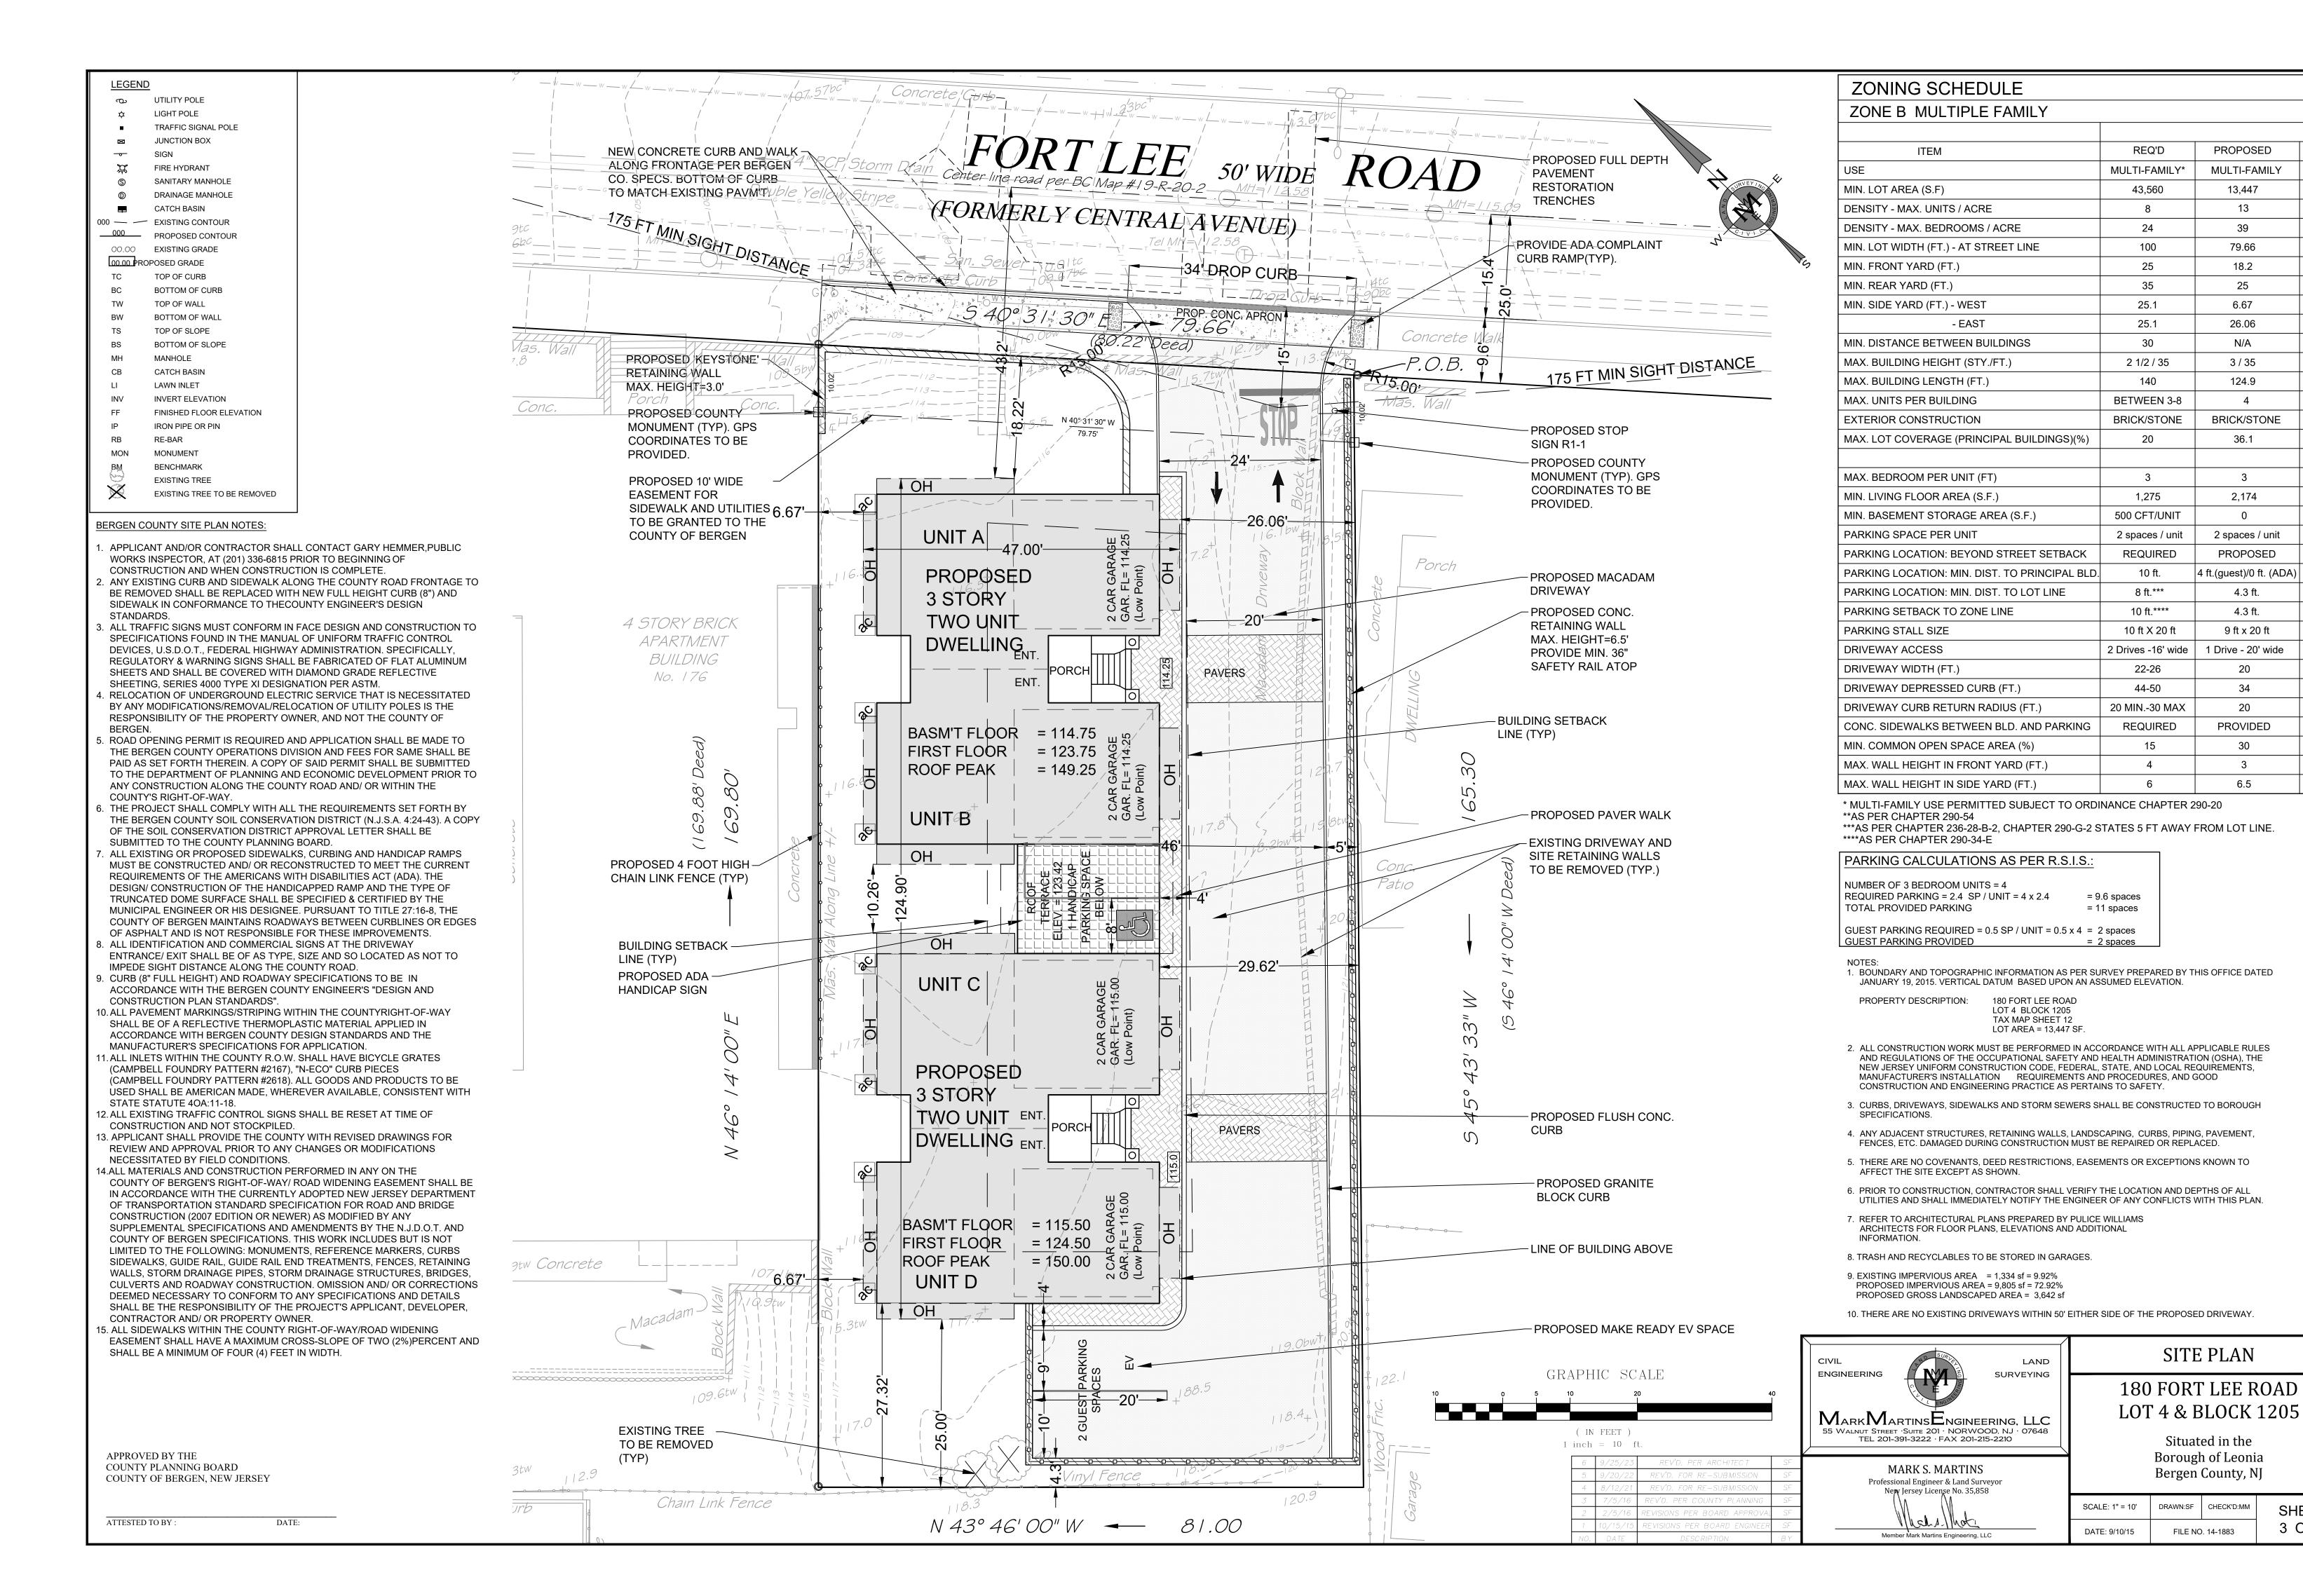

VAR.

YES

YES

YES

YES

YES

YES

YES

YES

NO

NO

YES

NO

NO

NO

YES

NO

NO

YES

NO

NO

YES

YES

YES

YES

YES

YES

YES

NO

NO


NO


NO

YES

SHEET

3 OF 7

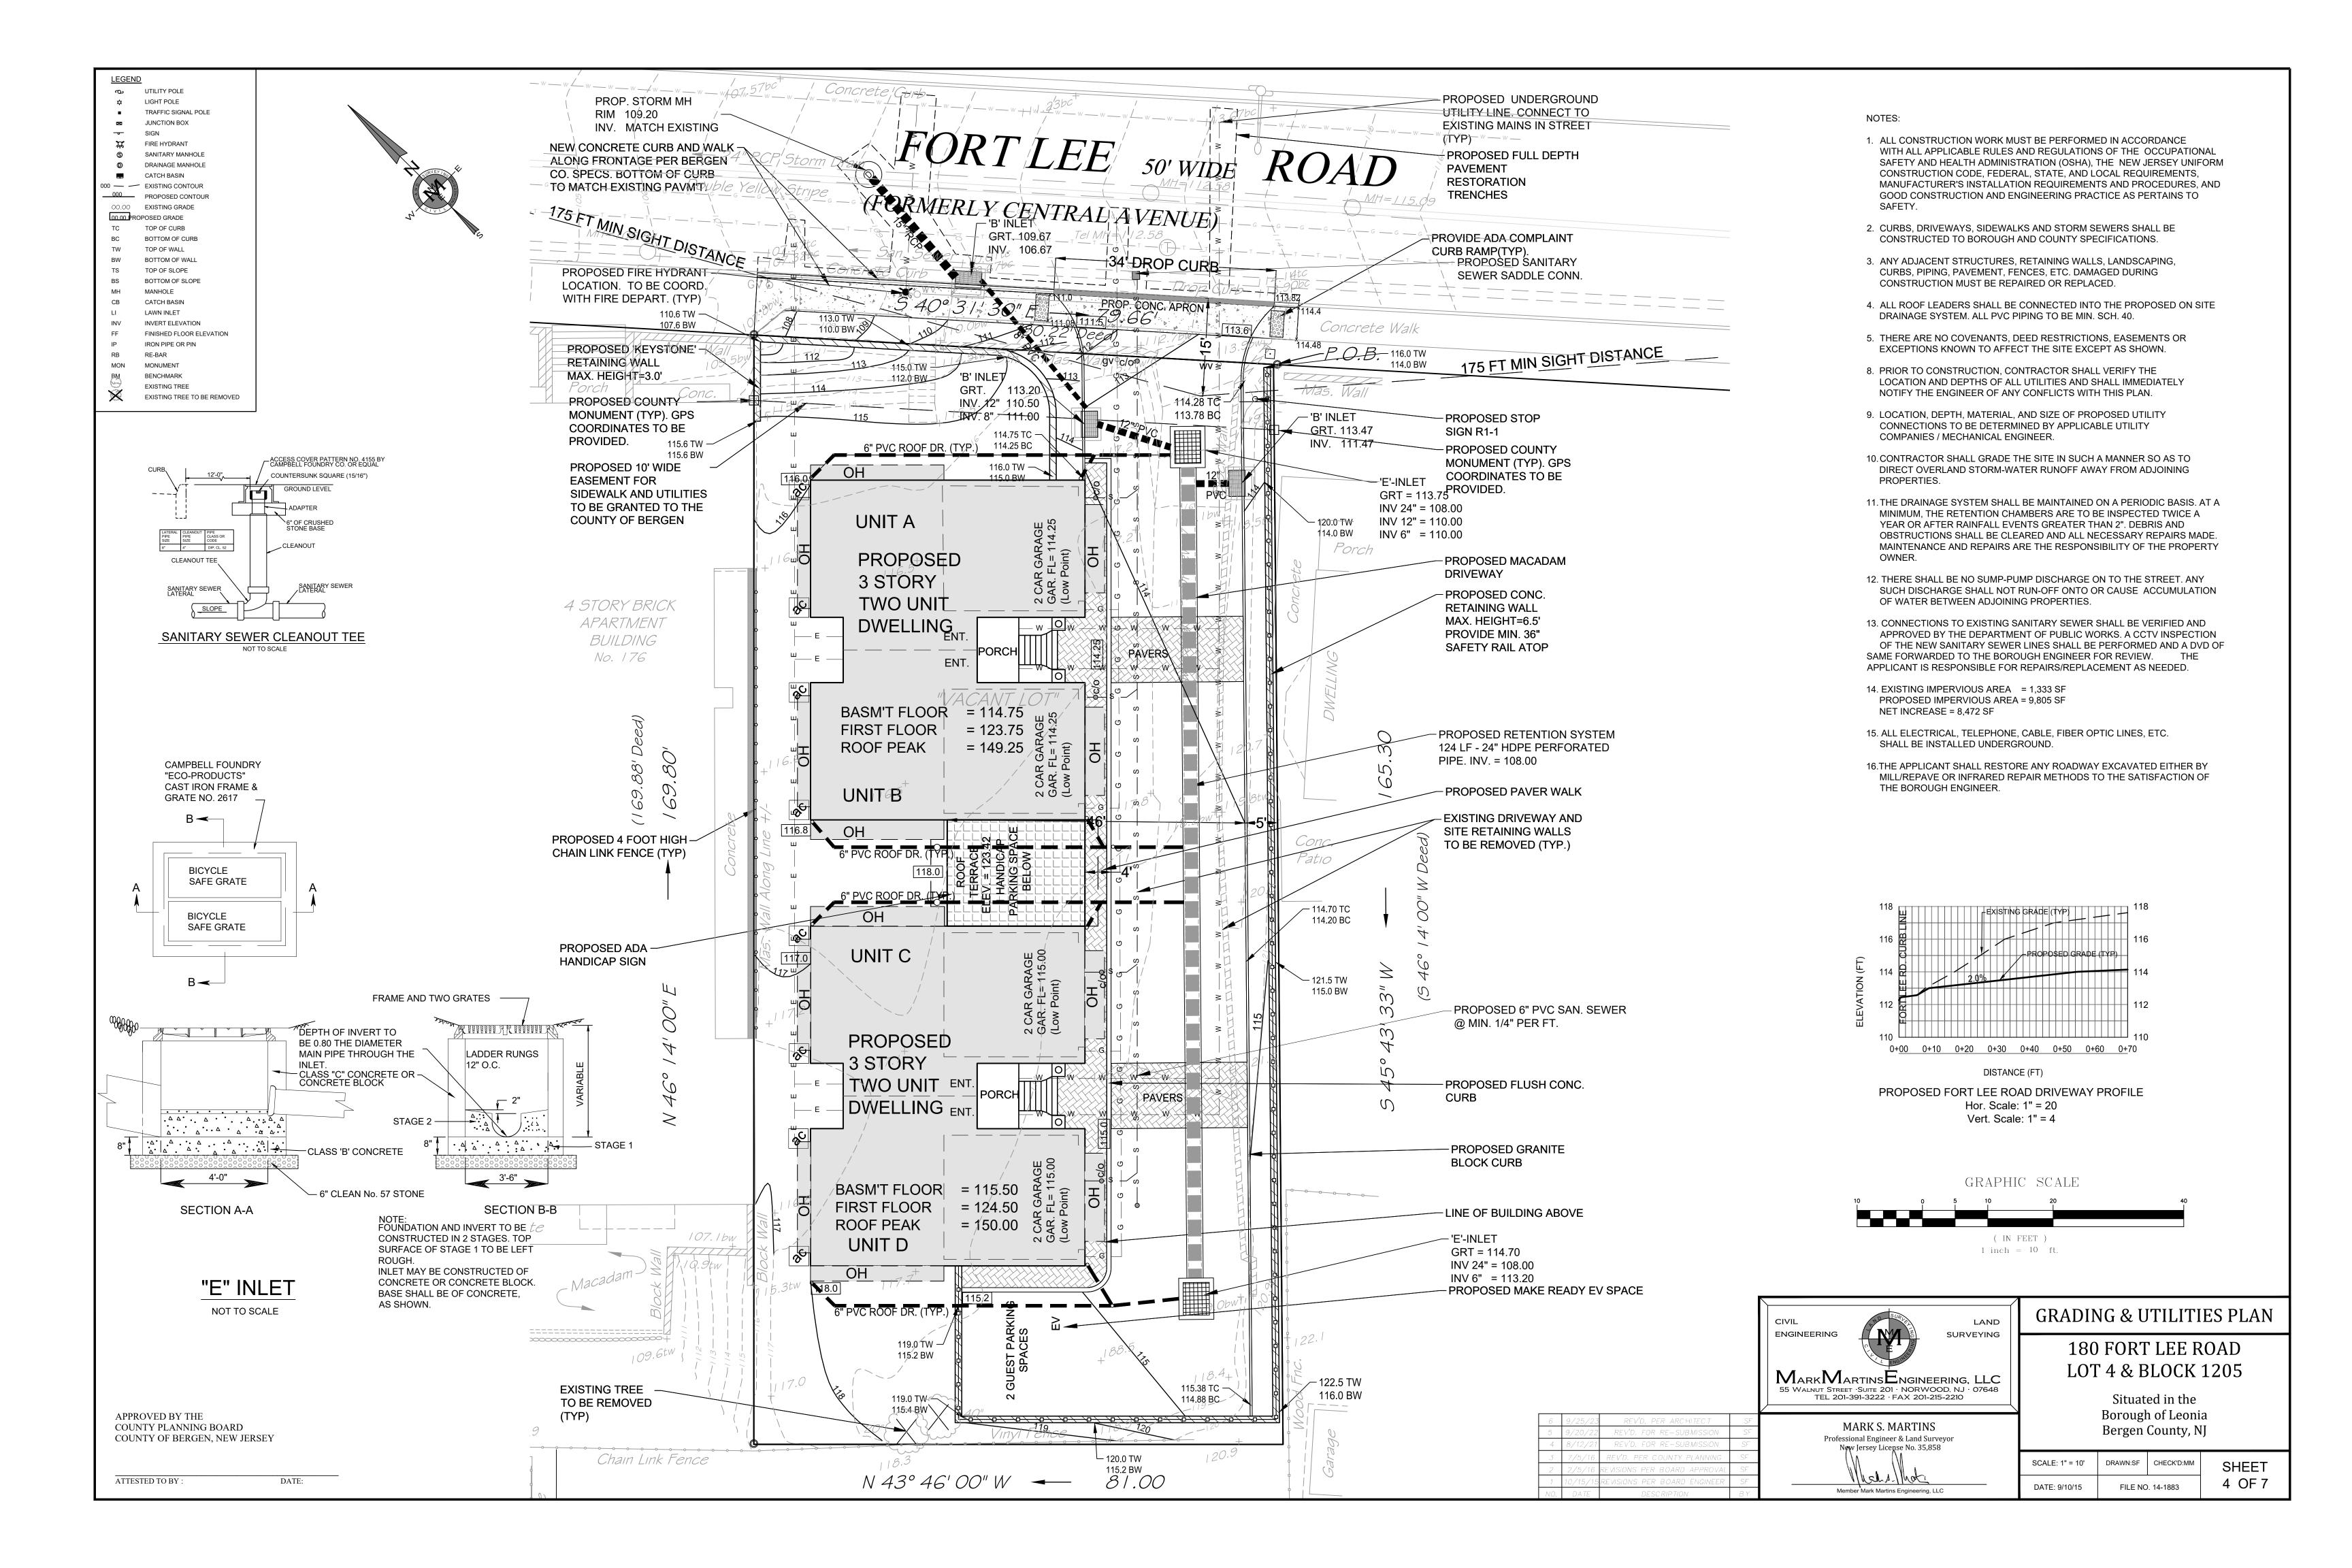

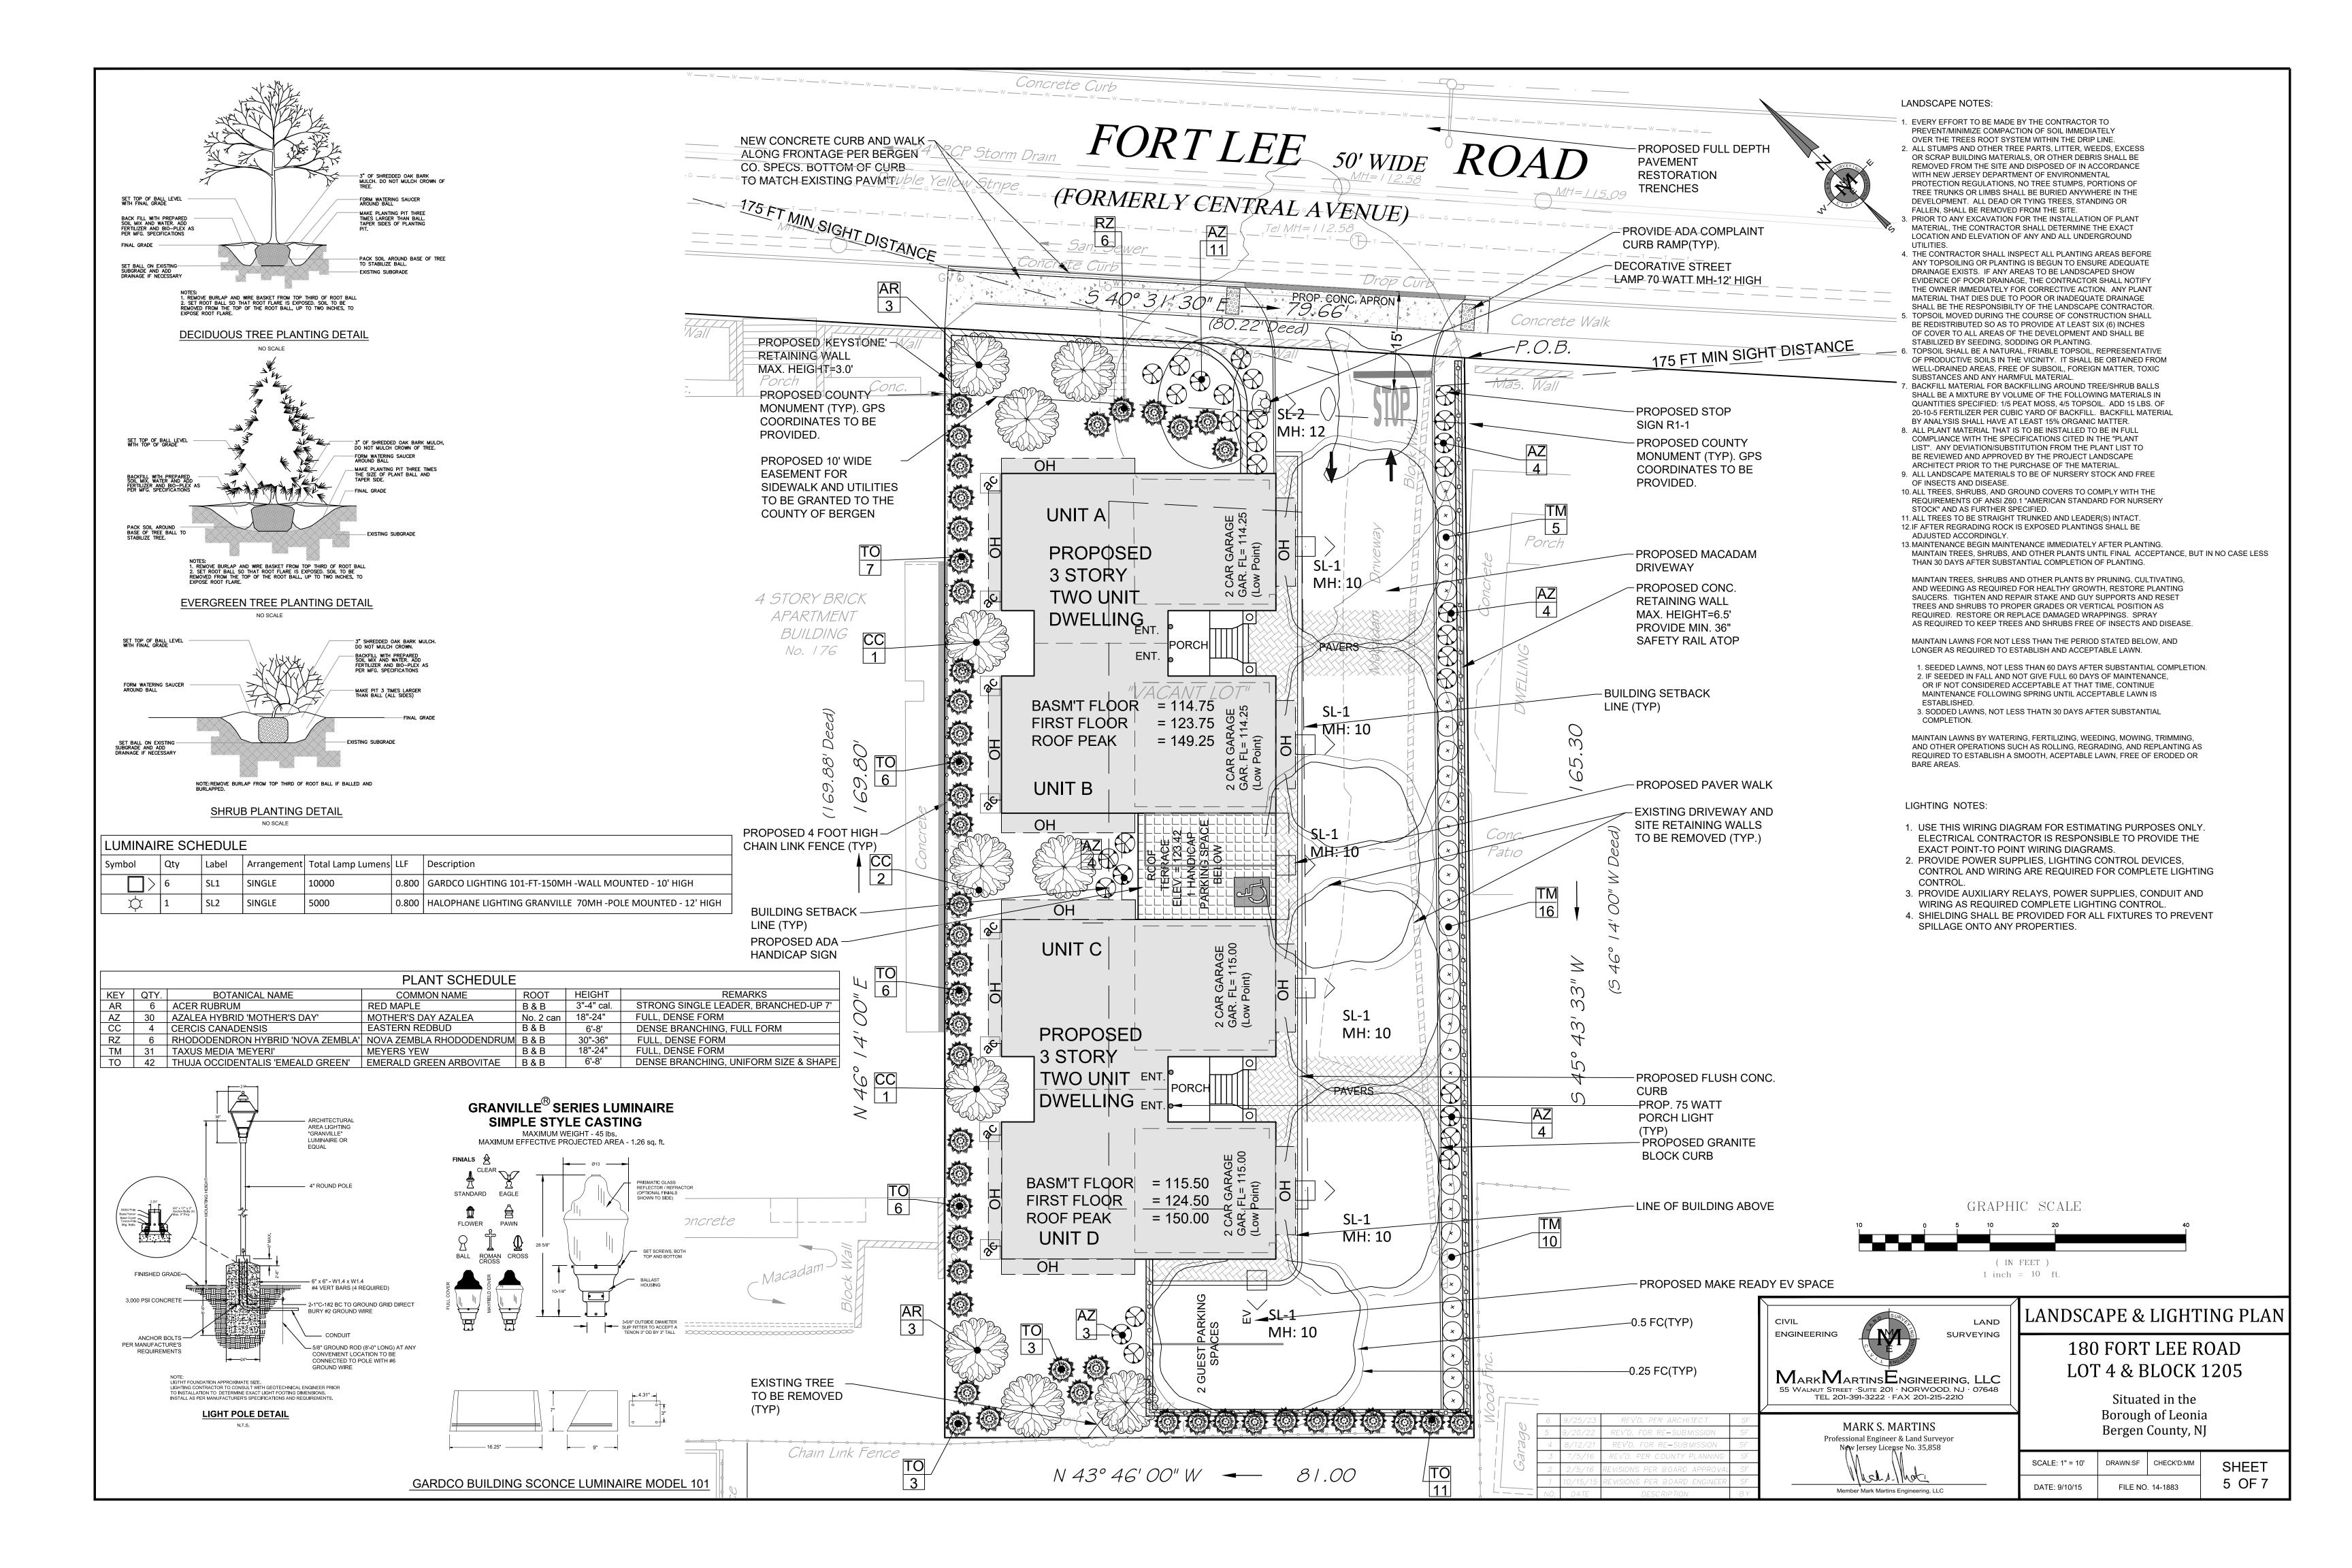

DRAWSTRING RUNNING THROUGH FENCE POST~ FABRIC ALONG TOP OF FENCE (8 FT. ON CENTER) 6" MIN. OF 1"- 2 17 PROVIDE APPROPRIATE FILTER FABRIC CRUSHED STONE ANSITION BETWEEN W/METAL FASTNERS AND UNDER STONE REINFORCEMENT BETWEEN FASTNER AND FABRIC STABILIZED CONSTRUCTION <u>PROFILE</u> ENTRANCE AND PUBLIC R.O.W. 2'-0" (MIN) (3'-0" WIDE) 50' OR GREATER AS REQUIRED DIG 6" WIDE & DEEP TRENCH, BURY BOTTOM 1'-0" OF FABRIC, TAMP IN PLACE. RIGHT - GROUND OF WAY

SILT FENCE DETAIL


STABILIZED CONSTRUCTION ENTRANCE


SEWER SYSTEM BY SLIT OPENINGS IN THE


'B' INLET FILTER DETAIL

<u>PLAN VIEW</u>

50' OR GREATER AS REQUIRED

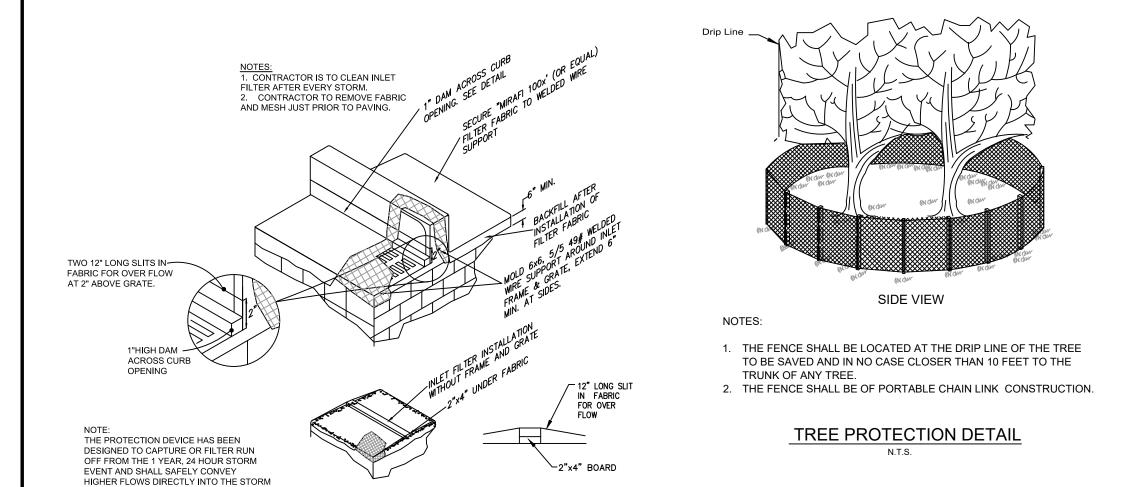

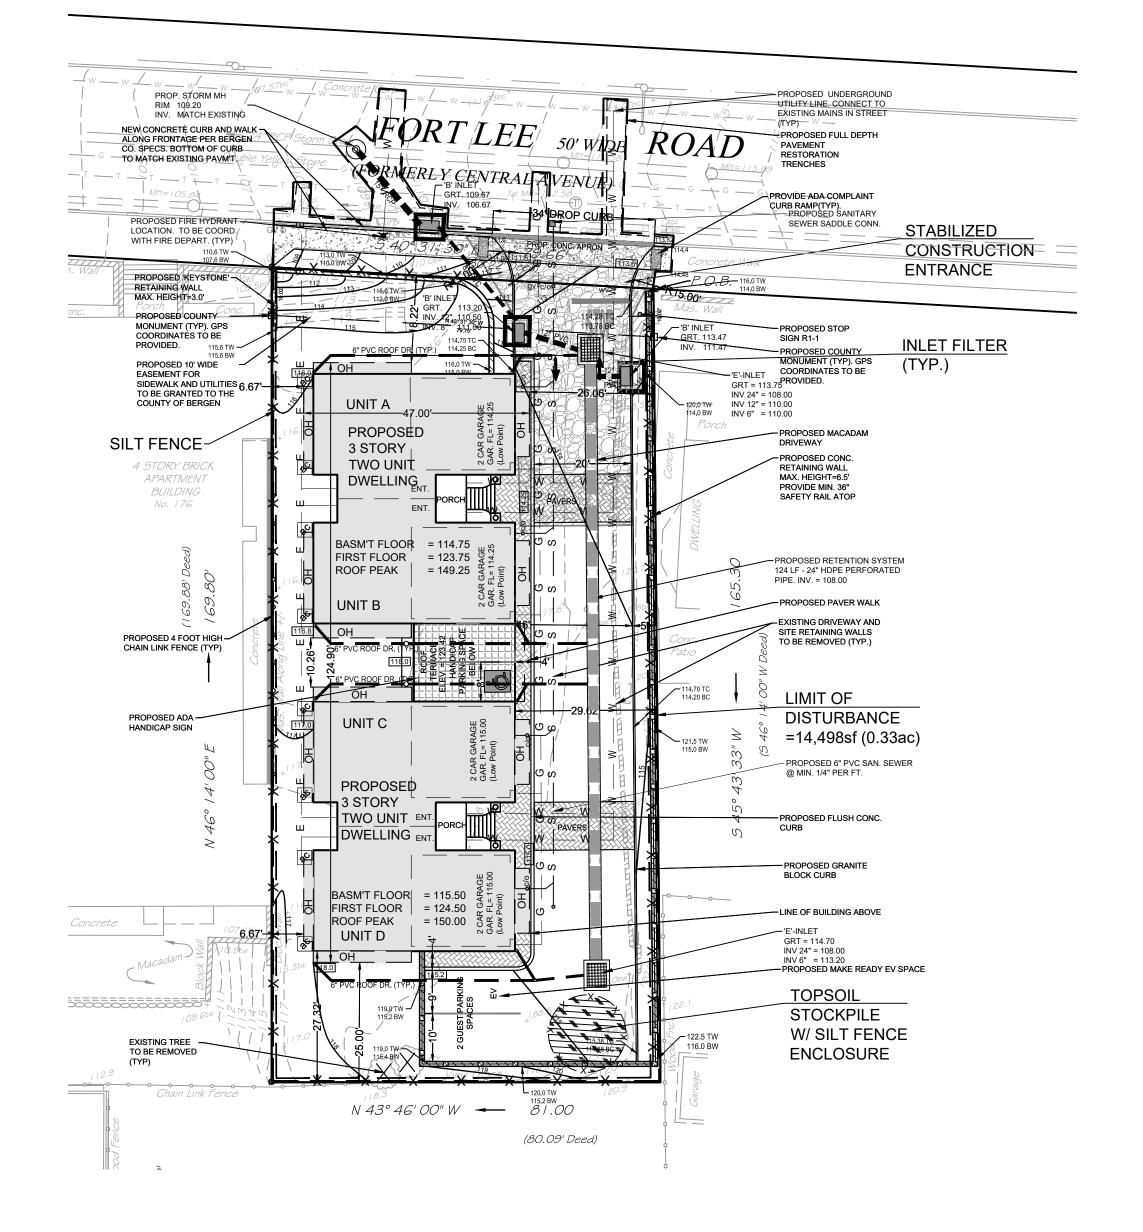

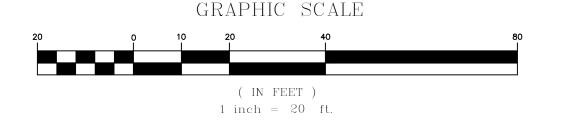

SOIL EROSION AND SEDIMENT CONTROL NOTES

- All soil erosion and sediment control practices will be installed in accordance with the Standards for Soil Erosion and Sediment Control in New Jersey (NJ Standards), and will be installed in proper sequence and maintained until permanent stabilization is established.
- 2. Any disturbed area that will be left exposed for more than thirty (30) days and not subject to construction traffic shall immediately receive a temporary seeding and mulching. If the season prohibits temporary seeding, the disturbed area will be mulched with salt hay or equivalent and bound in accordance with the NJ
- 3. Immediately following initial disturbance or rough grading, all critical areas subject to erosion will receive a temporary seeding in combination with straw mulch or a suitable equivalent, at a rate of 2 tons per acre, according to the

Standards (i.e. peg and twine, mulch netting, or liquid mulch binder).

4. <u>Stabilization Specifications</u>: A. Temporary Seeding and Mulching:

- -Ground Limestone Applied uniformly according to soil test recommendations.

 -Fertilizer Apply 11lbx./1,000 sf of 10-20-10 or equivalent with 50% water insoluble nitrogen, (unless a soil test indicates otherwise) worked into the soil a minimum of 4".
- Seed Perennial Ryegrass 100 lbs/acre (2.3 lb./1,000 sf) or other approved seeds; plant between March 1 and May 15 or between August 15 and October 1.
- Mulch Unrotted straw or hay at a rate of 70 to 90 lbs/1,000 sf, applied to achieve 95% soil surface coverage. Mulch shall be anchored by approved methods (i.e. peg and twine, mulch netting, or liquid mulch binder).
- B. Permanent Seeding and Mulching:Topsoil Uniform application to a depth of 5" (unsettled).
- Ground Limestone —Applied uniformily according to soil test recommendations.
 Fertilizer Apply 11lbs/1,000 sf of 10—10—10 or equivalent with 50% water unsoluble nitrogetn (unless a soil test indicates otherwise)
- unsoluble nitrogeth (unless a soil test indicates otherwise)

 Seed Turf type tall fescue (blend of 3 cultivars) 350 lbs./acre (8 lbs./1,000 s.f.) or other approved seeds; plant between March 1 and October 1. (summer seedings require irrigation)
- Mulch Unrotted straw or hay at a rate of 70 to 90 lbs/1,000 sf;
 to be applied to achieve 95% soil coverage. Mulch shall be anchored by approved methods (i.e. peg and twine, mulch netting, or liquid mulch binding).
- 5. The site shall at all times be graded and maintained such that all stormwater
- runoff is diverted to soil erosion and sediment control facilities.
- 6. Soil erosion and sediment control measures will be inspected and maintained on regular basis, including after every storm event.
- 7. Stockpiles are not to be located within 50' of a floodplain, slope, roadway or drainage facility. The base of all stockpiles shall be contained by a haybale sediment
- 8. A crushed stone, vehicle wheel—cleaning blanket will be installed wherever a construction access road intersects any paved roadway. Solid blanket will be composed of 1"-2½" crushed stone, 6" thick, will be at least 30'x100' and should
- be underlain with a suitable synthetic sediment filter fabric and maintained.

 9. Maximum side slopes of all exposed surfaces shall not exceed 3:1 unless otherwise approved by the District.
- 10. Driveways must be stabilized with $1"-2\frac{1}{2}"$ crushed stone or subbase prior to individual lot construction.

at the project site throughout construction.

- 11. All soil washed, dropped, spilled or tracked outside the limit of disturbed or onto public right—of ways, will be removed immediately. Paved roadways must be kept clean
- 12. All catch basin inlets will be protected with an inlet filter designed in accordance with Section 28—1 of the NJ Standards.
- 13. Storm drainage outlets will be stabilized, as required, before the discharge points become operational.
- 14. Dewatering operations must discharge directly into a sediment control bag or other approved filter in accordance with Section 14-1 of the NJ Standards.
- 15. Dust shall be controlled via the application of water, calcium chloride or other approved filter in accordance with Section 16—1 of the NJ Standards.
- 16. Trees to remain after construction are to be protected with a suitable fence installed at the drip line or beyond in accordance with Section 9-1 of the NJ Standards.
 17. The project owner shall be responsible for any erosion or sedimentation that may
- occur below stormwater outfalls or off—site as a result of construction of the project.

 18. Any revision to the certified Soil Erosion and Sediment Control Plan must be submitted to the District for review and approval prior to implementation in the field.

 19. A copy of the certified Soil Erosion and Sediment Control Plan must be available
- 20. The Bergen County Soil Conservation District must be notified, in writing, at least 48 hours prior to any land disturbance: Bergen County SCD, 700 Kinderkamack Road, Suite 106, Oradell, NJ 07649 Tel: 201–261–4407; Fax 201–261–7573.
- 21. The Bergen County Soil Conservation District may request additional measures to minimize on or off—site erosion problems during construction.
- 22. The owner must obtain a District issued report of compliance prior to the issuance of any certificate of occupancy. The District requires at least one week's notice to facilitate the scheduling of all report of compliance inspections. All site work must be completed, including temporary/permanent stabilization of all exposed areas, prior to

.. ----Revised 6/14

SOIL EROSION CONSTRUCTION SEQUENCE:

the issuance of a report of compliance by the District.

- DEMOLISH EXISTING BUILDING AND STRUCTURES. REMOVE EXISTING PAVEMENT AND CURBS 1st WEEK.
- 2 INSTALL CONSTRUCTION ENTRANCE SILT FENCES STRIP TORSOIL 1st 2rd DAV
- 2. INSTALL CONSTRUCTION ENTRANCE, SILT FENCES, STRIP TOPSOIL 1st 3rd DAY
- 3. CONSTRUCT PROPOSED STORM DRAINAGE SYSTEM. INSTALL INLET FILTERS 2nd WEEK4. EXCAVATE AND ROUGH GRADE SITE. TEMPORARY SEED/MULCH DISTURBED AREAS
- 5. CONSTRUCT PROPOSED BUILDING AND RETAINING WALLS 4th WEEK 52nd WEEK
- 6. BACKFILL FOUNDATION 6th WEEK.

3rd - 4 th WEEK.

- 7. CONSTRUCT PROPOSED CURBING 48th WEEK.
- 8. PAVE PARKING AREAS AND DRIVEWAYS 50th WEEK.
- 9. FINAL GRADING, PLANTING, SEEDING, REMOVAL OF SOIL EROSION PROTECTION MEASURES UPON PERMITTED STABILIZATION OF PREVIOUSLY EXPOSED AREAS 52nd WEEK.

CIVIL ENGINEERING SURVEYING

MARK MARTINS ENGINEERING, LLC
55 WALNUT STREET 'SUITE 201 · NORWOOD, NJ · 07648
TEL 201-391-3222 · FAX 201-215-2210

MARK S. MARTINS

Professional Engineer & Land Surveyor

New Jersey License No. 35,858

Member Mark Martins Engineering, LLC

SOIL EROSION CONTROL PLAN

180 FORT LEE ROAD LOT 4 & BLOCK 1205

Situated in the Borough of Leonia Bergen County, NJ

| CALE: 1" = 20' | DRAWN:SF | CHECK'D:MM | SHEET |
|----------------|------------------|------------|--------|
| OATE: 9/10/15 | FILE NO. 14-1883 | | 6 OF 7 |

